
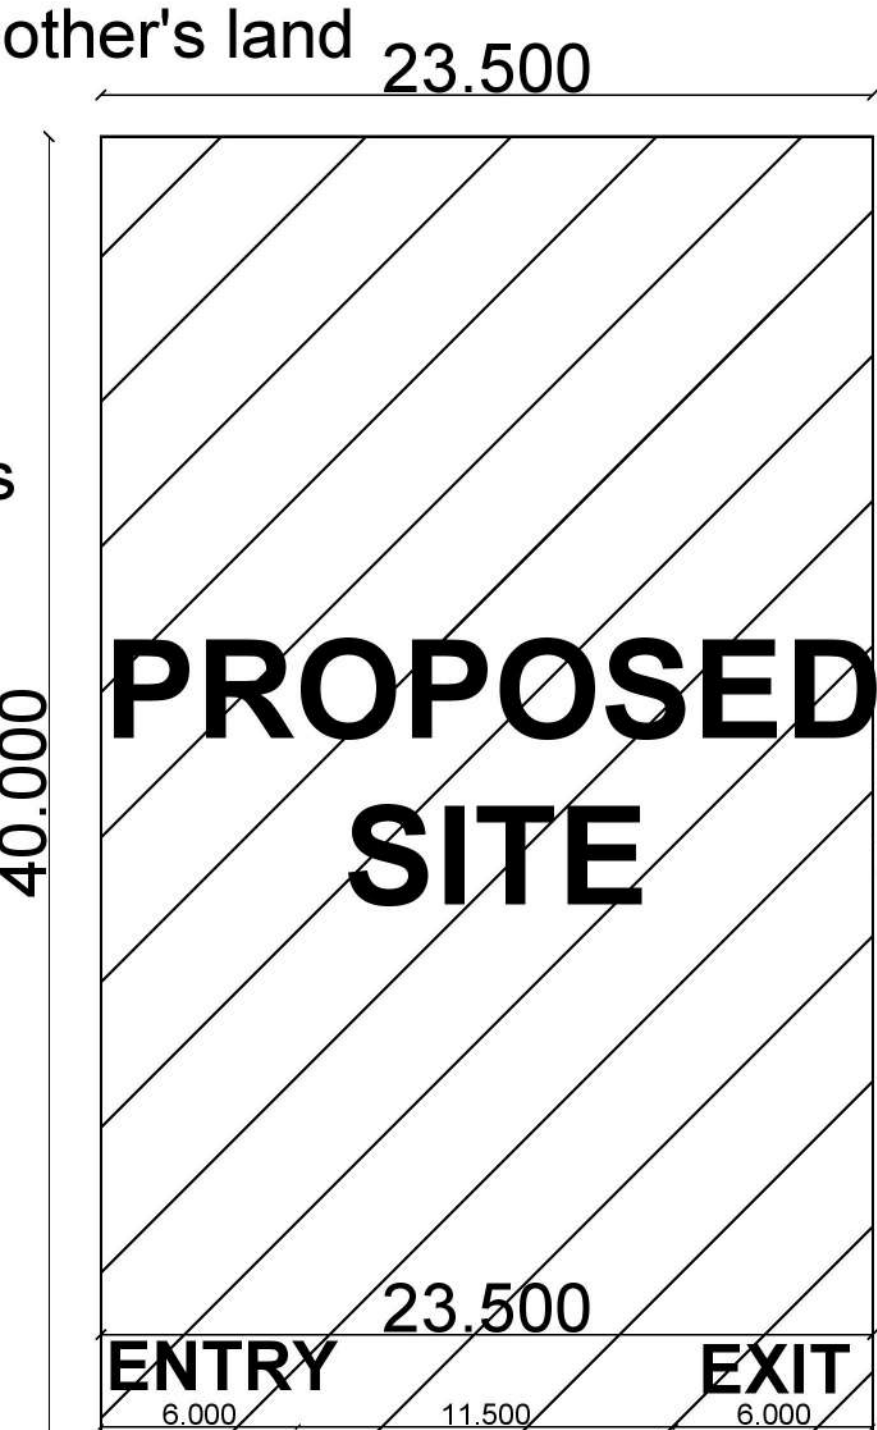


TOTAL SITE AREA
VILLAGE
TEHSIL
DISTRICT
STATE

0.094 HECTARES
KHARKHODA
KHARKHODA
SONIPAT
HARYANA

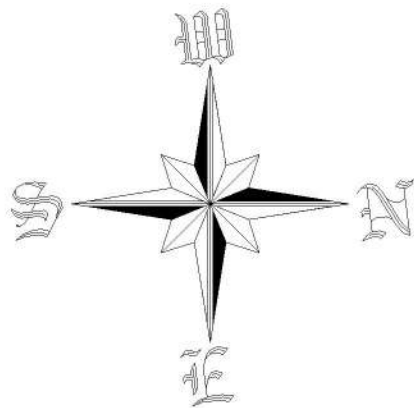


APPROACH ROAD AREA

AREA A+A' = $2(6.000 \times 8.229)$
= 98.748 SQMT.

AREA B+B' = $2(\frac{1}{2} \times 5.00 \times 5.00 - \frac{2}{3} \times 7.07 \times 1.46)$
= $2(12.500 - 6.881)$
= 11.238 sqmt.

TOTAL AREA = 98.748 + 11.238
= 109.986 sqmt.
= 0.011 HECTARES

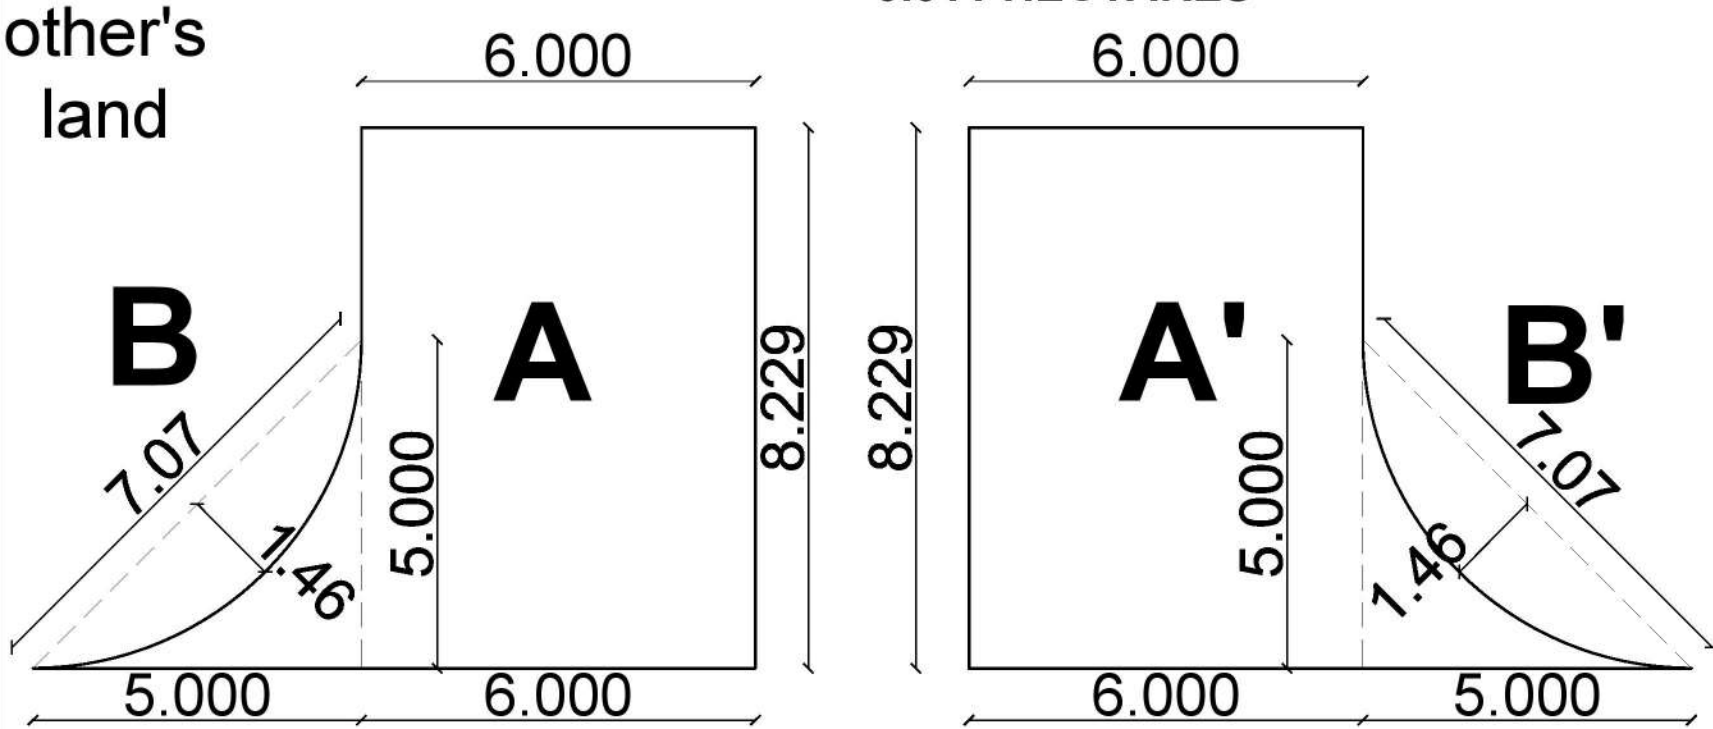

PWD LAND BOUNDARY
8.229m wide kacha berm

PWD LAND BOUNDARY
8.229m wide kacha berm



TOWARDS SONIPAT

7.00M WIDE METTALED ROAD

10.80m wide central verge

TOWARDS SAMPLA

7.00M WIDE METTALED ROAD

8.229m wide kacha berm

NOTES:-

- 1.DRAWING AND DIMENSIONS ARE ONLY TO BE READ AND NOT SCALED.
- 2.UNLESS OTHERWISE MENTIONED, ALL DIMENSIONS ARE GIVEN IN FEET - INCHES.
- 3.THIS DRAWING SHALL BE READ IN CONJUNCTION WITH RELEVANT ARCHITECTURAL, STRUCTURAL AND SERVICE DRAWINGS.
- 4.ALL LEVELS GIVEN IN DRAWING ARE WITH REFERENCE TO THE ROAD LEVEL AS BENCHMARKED AT SITE.
- 5.ANY DISCREPANCY BETWEEN THE ARCHITECTURAL / STRUCTURAL OR SERVICES DRAWINGS MUST BE BROUGHT TO THE ATTENTION OF THE ARCHITECT BY THE CONTRACTOR OR PROJECT MANAGER BEFORE EXECUTION OF THE SAME.
6. THIS DRAWING & DESIGN IS THE COPYRIGHT OF THE ARCHITECT & CAN NOT BE REPRODUCED IN ANY FORM WITHOUT WRITTEN CONSENT FROM THE ARCHITECT

USER AGENCY:


GATI BODH JAUHAL
Deputy General Manager (RS)
Indian Oil Corporation Ltd.
Panipat - Divisional Office
Panipat Refinery
Panipat-132140

Gati Bodh Jauhal,
Deputy General Manager Retail Sales,
IOCL, Panipat Divisional Office, Panipat

ARCHITECT:

DRAWING NAME:

SITE PLAN

SCALE : NTS

PLOT SIZE:
940.00 sqmt.

PROJECT NAME:
SITE PLAN OF RETAIL OUTLET OF INDIAN OIL CORPORATION LIMITED ON SONIPAT CHOWK TO SAMPLA CHOWK NEW 334B (KHARKHODA BYPASS) AT CHAINAGE 37.100 (R.H.S.) AT VILLAGE - KHARKHODA II, TEHSIL- KHARKHODA, DISTT. - SONIPAT (HARYANA)

DATE:

16/11/2021

DRG. NO.:

01



DRAWN BY:

PRINCIPAL ARCHITECT:

Ar. NISHANT SINGLA

ARCHITECTS & INTERIOR DESIGNERS
EMAIL -> nishantsingla@gmail.com